



DEPARTMENT OF PERMITTING, ENVIRONMENT, AND REGULATORY
AFFAIRS (PERA)
BOARD AND CODE ADMINISTRATION DIVISION

NOTICE OF ACCEPTANCE (NOA)

MIAMI-DADE COUNTY
PRODUCT CONTROL SECTION
11805 SW 26 Street, Room 208
Miami, Florida 33175-2474
T (786) 315-2590 F (786) 315-2599

www.miamidade.gov/pera/

WinDoor, Inc.
7500 Amsterdam Drive
Orlando, FL 32832

SCOPE:

This NOA is being issued under the applicable rules and regulations governing the use of construction materials. The documentation submitted has been reviewed and accepted by Miami-Dade County PERA - Product Control Section to be used in Miami Dade County and other areas where allowed by the Authority Having Jurisdiction (AHJ).

This NOA shall not be valid after the expiration date stated below. The Miami-Dade County Product Control Section (In Miami Dade County) and/or the AHJ (in areas other than Miami Dade County) reserve the right to have this product or material tested for quality assurance purposes. If this product or material fails to perform in the accepted manner, the manufacturer will incur the expense of such testing and the AHJ may immediately revoke, modify, or suspend the use of such product or material within their jurisdiction. PERA reserves the right to revoke this acceptance, if it is determined by Miami-Dade County Product Control Section that this product or material fails to meet the requirements of the applicable building code.

This product is approved as described herein, and has been designed to comply with the Florida Building Code, including the High Velocity Hurricane Zone.

DESCRIPTION: Series "1000" Aluminum Fixed Window - S.M.I.

APPROVAL DOCUMENT: Drawing No. **WIND0075**, titled "Series 1000 Fixed Window Small Missile", sheets 1 through 8 of 8, dated 10/28/05, with revision B dated 11/26/08, prepared by manufacturer, signed and sealed by Luis R. Lomas, P.E., bearing the Miami-Dade County Product Control Revision stamp with the Notice of Acceptance number and expiration date by the Miami-Dade County Product Control Section.

MISSILE IMPACT RATING: Small Missile Impact Resistant

LABELING: Each unit shall bear a permanent label with the manufacturer's name or logo, city, state, model/series, and following statement: "Miami-Dade County Product Control Approved", unless otherwise noted herein.

RENEWAL of this NOA shall be considered after a renewal application has been filed and there has been no change in the applicable building code negatively affecting the performance of this product.

TERMINATION of this NOA will occur after the expiration date or if there has been a revision or change in the materials, use, and/or manufacture of the product or process. Misuse of this NOA as an endorsement of any product, for sales, advertising or any other purposes shall automatically terminate this NOA. Failure to comply with any section of this NOA shall be cause for termination and removal of NOA.

ADVERTISEMENT: The NOA number preceded by the words Miami-Dade County, Florida, and followed by the expiration date may be displayed in advertising literature. If any portion of the NOA is displayed, then it shall be done in its entirety.

INSPECTION: A copy of this entire NOA shall be provided to the user by the manufacturer or its distributors and shall be available for inspection at the job site at the request of the Building Official.

This NOA revises NOA # 11-0223.15 and consists of this page 1 and evidence page E-1, as well as approval document mentioned above.

The submitted documentation was reviewed by **Manuel Perez, P.E.**



Handwritten signature and date:
3/28/12

NOA No. 12-0130.27
Expiration Date: June 22, 2016
Approval Date: April 05, 2012
Page 1

NOTICE OF ACCEPTANCE: EVIDENCE SUBMITTED

A. DRAWINGS

1. Manufacturer's die drawings and sections.
2. Drawing No. **WIND0075**, titled "Series 1000 Fixed Window Small Missile", sheets 1 through 8 of 8, dated 10/28/05, with revision B dated 11/26/08, prepared by manufacturer, signed and sealed by Luis R. Lomas, P.E.

B. TESTS

1. Test reports on: 1) Air Infiltration Test, per FBC, TAS 202-94
2) Uniform Static Air Pressure Test, Loading per FBC, TAS 202-94
3) Water Resistance Test, per FBC, TAS 202-94
4) Small Missile Impact Test per FBC, TAS 201-94
5) Cyclic Wind Pressure Loading per FBC, TAS 203-94
along with marked-up drawings and installation diagram of an aluminum fixed window, prepared by National Certified Testing Laboratories, Test Report No. **NCTL-210-2971-2**, dated 03/03/04 and re-issued on 07/20/05, signed and sealed by Gerald J. Ferrara, P.E. *(Submitted under NOA # 05-1114.07)*

C. CALCULATIONS

1. Anchor verification calculations and structural analysis, complying with FBC-2007, dated 06/02/08, prepared, signed and sealed by Luis R. Lomas, P.E.
(Submitted under previous NOA # 11-0223.15)
2. Glazing complies with ASTM E1300-04

D. QUALITY ASSURANCE

1. Miami-Dade Department of Permitting, Environment, and Regulatory Affairs (PERA).

E. MATERIAL CERTIFICATIONS


1. Notice of Acceptance No. **11-0325.05** issued to Solutia, Inc. for their "**Saflex and Vanceva clear and color interlayers**" dated 05/05/11, expiring on 05/21/16


F. STATEMENTS

1. Statement letter of conformance, complying with FBC-2010, and of no financial interest, dated January 19, 2012, signed and sealed by Luis R. Lomas, P.E.
2. Laboratory compliance letter for Test Report No. **NCTL-210-2971-2**, issued by National Certified Testing Laboratories, dated 07/20/05, signed and sealed by Gerald J. Ferrara, P.E. *(Submitted under previous NOA#05-1114.07)*

G. OTHER

1. Notice of Acceptance No. **11-0223.15**, issued to WinDoor, Inc. for their Series "1000" Aluminum Fixed Window – S.M.I., approved on 03/31/11 and expiring on 06/22/16.

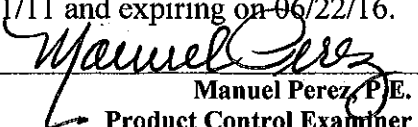
Manuel Perez, P.E.
Product Control Examiner
NOA No. 12-0130.27
Expiration Date: June 22, 2016
Approval Date: April 05, 2012

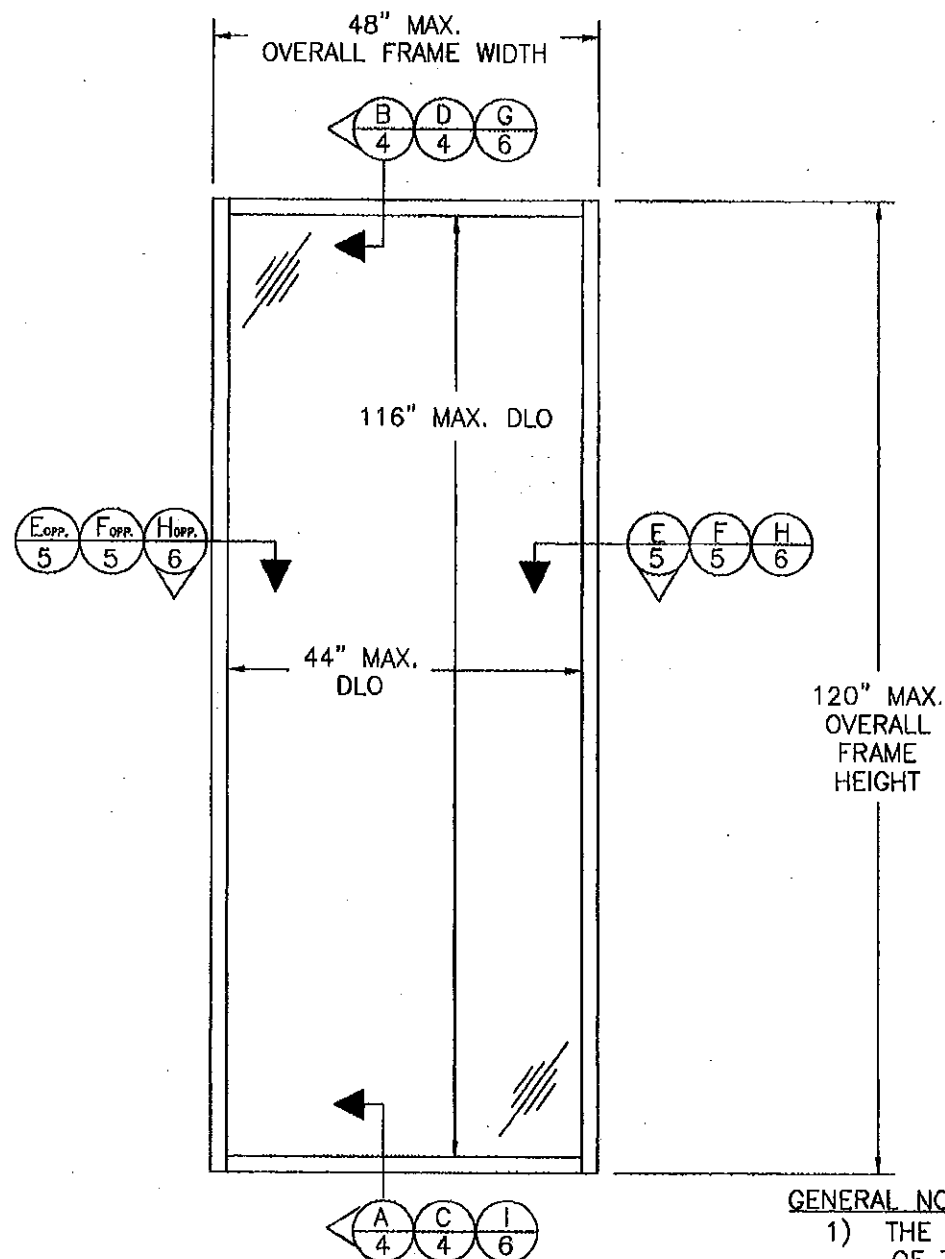


SERIES 1000 FIXED WINDOW SMALL MISSILE
EXTERIOR ELEVATION

DRAWING NUMBER	DESCRIPTION
1	ELEVATIONS & GENERAL NOTES
2	DESIGN PRESSURE CHARTS
3	ANCHORING ELEVATIONS & INSTALLATION NOTES
4	VERTICAL CROSS SECTIONS
5	HORIZONTAL CROSS SECTIONS
6	STEEL STUD CROSS SECTIONS
7	GLAZING DETAILS
8	BOM & COMPONENTS

GENERAL NOTES:

- 1) THE PRODUCT SHOWN HEREIN COMPLIES WITH REQUIREMENTS OF THE CURRENT FLORIDA BUILDING CODE INCLUDING THE HVHZ.
- 2) WOOD BUCK OR STUD FRAMING TO BE DESIGNED AND ANCHORED TO PROPERLY TRANSFER ALL LOADS TO STRUCTURE, BUCK OR FRAMING IS RESPONSIBILITY OF ARCHITECT OF RECORD.
- 3) PRODUCTS ARE APPROVED FOR USE WHERE SMALL MISSILE IMPACT RESISTANCE IS REQUIRED. IMPACT PROTECTIVE SYSTEM IS NOT REQUIRED, FOR INSTALLATION OF THIS PRODUCT 30' OR MORE ABOVE GROUND LEVEL.
- 4) FOR DESIGN PRESSURE CAPACITIES, SEE SHEETS 2.
- 5) ALLOWABLE STRESS INCREASE OF 1/3, WAS NOT USED IN THE DESIGN OF THE PRODUCT SHOWN HEREIN.

1-8	B	REVISED PER DADE LETTER DATED NOV. 10, 2008	11/26/08	TJH
1-8	A	General revision and update to current building code	07/31/08	DRL
SHEET	REV	DESCRIPTION	DATE	BY
REVISIONS				

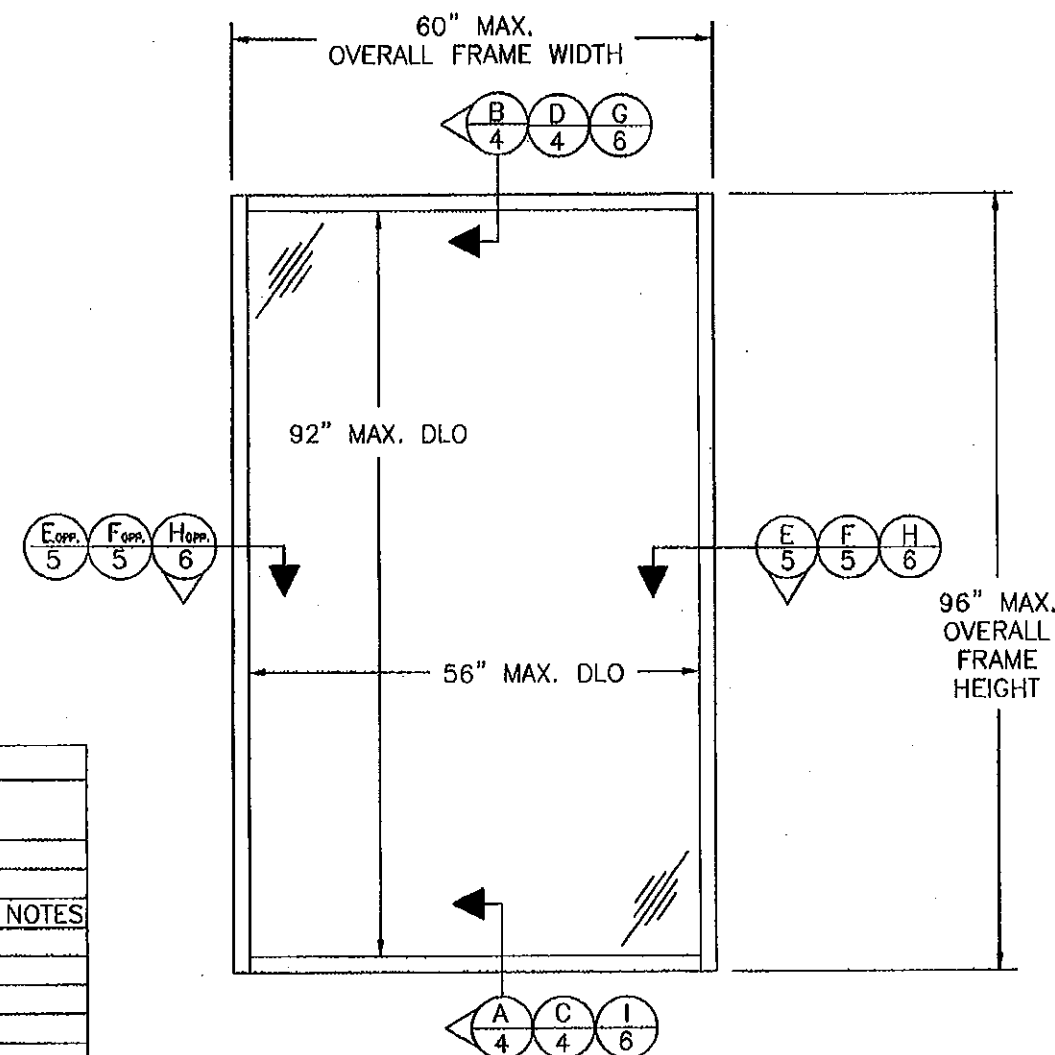

SERIES 1000 FIXED WINDOW SMALL MISSILE
EXTERIOR ELEVATION

PRODUCT REVISED
as complying with the Florida
Building Code
Acceptance No. 12-0130.27
Expiration Date JUNE 22, 2016
By *Mamuel Perez*
Miami Dade Product Control

PRODUCT RENEWED
as complying with the Florida
Building Code
Acceptance No. 11-0223.15
Expiration Date JUNE 22, 2016
By *Mamuel Perez*
Miami Dade Product Control

PRODUCT REVISED
as complying with the Florida
Building Code
Acceptance No. 08-1010.12
Expiration Date JUNE 22, 2011
By *Mamuel Perez*
Miami Dade Product Control

LUIS R. LOMAS P.E.

Luis R. Lomas
2/8/09

FLORIDA REGISTRATION
NO. 62514

WinDoor
INCORPORATED

7500 AMSTERDAM DRIVE
ORLANDO, FL 32832
Phone 407.481.8400
Fax 407.481.0505
www.windoorinc.com

Dwg Title:

SERIES 1000 FIXED WINDOW SMALL MISSILE
ELEVATIONS AND GENERAL NOTES

SIZE	Drn By:	DWG NO.	REV
B	JVS	WIND0075	B
SCALE N.T.S.	DATE:	10/28/05	SHEET 1 OF 8

Height (in)	Panel width (in)									
	24.0		30.0		36.0		42.0		48.0	
	Pos	Neg	Pos	Neg	Pos	Neg	Pos	Neg	Pos	Neg
36.0	150.0	175.0	160.0	175.0	160.0	175.0	160.0	175.0	160.0	175.0
42.0	160.0	175.0	160.0	175.0	160.0	175.0	160.0	175.0	160.0	175.0
48.0	160.0	175.0	160.0	175.0	160.0	175.0	160.0	175.0	160.0	175.0
54.0	160.0	175.0	160.0	175.0	160.0	175.0	160.0	175.0	160.0	175.0
60.0	160.0	175.0	160.0	175.0	160.0	175.0	160.0	175.0	160.0	175.0
66.0	160.0	175.0	160.0	175.0	160.0	175.0	160.0	175.0	160.0	175.0
72.0	160.0	175.0	160.0	175.0	160.0	175.0	160.0	175.0	160.0	175.0
78.0	160.0	175.0	160.0	175.0	160.0	175.0	160.0	175.0	160.0	175.0
84.0	160.0	175.0	160.0	175.0	160.0	175.0	160.0	175.0	160.0	175.0
90.0	160.0	175.0	160.0	175.0	160.0	175.0	160.0	175.0	160.0	175.0
96.0	160.0	175.0	160.0	175.0	160.0	175.0	160.0	175.0	160.0	175.0
102.0	160.0	175.0	160.0	175.0	160.0	175.0	160.0	175.0	160.0	175.0
108.0	160.0	175.0	160.0	175.0	160.0	175.0	160.0	175.0	160.0	175.0
114.0	160.0	175.0	160.0	175.0	160.0	175.0	160.0	175.0	160.0	175.0
120.0	160.0	175.0	160.0	175.0	160.0	175.0	160.0	175.0	160.0	175.0

Height (in)	Panel width (in)									
	24.0		30.0		36.0		42.0		48.0	
	Pos	Neg	Pos	Neg	Pos	Neg	Pos	Neg	Pos	Neg
36.0	120.0	160.0	120.0	160.0	120.0	160.0	120.0	160.0	120.0	160.0
42.0	120.0	160.0	120.0	160.0	120.0	160.0	120.0	160.0	120.0	160.0
48.0	120.0	160.0	120.0	160.0	120.0	160.0	120.0	160.0	120.0	160.0
54.0	120.0	160.0	120.0	160.0	120.0	160.0	120.0	160.0	120.0	160.0
60.0	120.0	160.0	120.0	160.0	120.0	160.0	120.0	160.0	120.0	142.0
66.0	120.0	160.0	120.0	160.0	120.0	160.0	120.0	143.6	120.0	134.0
72.0	120.0	160.0	120.0	160.0	120.0	160.0	120.0	138.1	120.0	128.0
78.0	120.0	160.0	120.0	160.0	120.0	148.4	120.0	133.9	120.0	123.0
84.0	120.0	160.0	120.0	160.0	120.0	145.3	120.0	130.4	119.8	119.0
90.0	120.0	160.0	120.0	160.0	120.0	142.7	120.0	127.8	118.7	116.0
96.0	120.0	160.0	120.0	160.0	120.0	140.6	120.0	125.2	114.1	114.0
102.0	120.0	160.0	120.0	160.0	120.0	136.6	120.0	123.2	111.9	111.0
108.0	120.0	160.0	120.0	160.0	120.0	137.0	120.0	121.4	110.1	110.0
114.0	120.0	160.0	120.0	160.0	120.0	135.5	119.9	119.9	108.4	108.0
120.0	120.0	160.0	120.0	160.0	120.0	134.3	118.6	118.6	107.0	107.0

Height (in)	Panel width (in)									
	24.0		30.0		36.0		42.0		48.0	
	Pos	Neg	Pos	Neg	Pos	Neg	Pos	Neg	Pos	Neg
36.0	134.0	160.0	134.0	160.0	134.0	160.0	134.0	160.0	134.0	160.0
42.0	134.0	160.0	134.0	160.0	134.0	160.0	134.0	160.0	134.0	160.0
48.0	134.0	160.0	134.0	160.0	134.0	160.0	134.0	160.0	134.0	160.0
54.0	134.0	160.0	134.0	160.0	134.0	160.0	134.0	160.0	134.0	160.0
60.0	134.0	160.0	134.0	160.0	134.0	160.0	134.0	160.0	134.0	160.0
66.0	134.0	160.0	134.0	160.0	134.0	160.0	134.0	160.0	134.0	160.0
72.0	134.0	160.0	134.0	160.0	134.0	160.0	134.0	160.0	134.0	160.0
78.0	134.0	160.0	134.0	160.0	134.0	160.0	134.0	160.0	134.0	160.0
84.0	134.0	160.0	134.0	160.0	134.0	160.0	134.0	160.0	134.0	160.0
90.0	134.0	160.0	134.0	160.0	134.0	160.0	134.0	160.0	134.0	148.0
96.0	134.0	160.0	134.0	160.0	134.0	160.0	134.0	160.0	134.0	142.0
102.0	134.0	160.0	134.0	160.0	134.0	160.0	134.0	160.0	134.0	140.0
108.0	134.0	160.0	134.0	160.0	134.0	160.0	134.0	160.0	134.0	137.0
114.0	134.0	160.0	134.0	160.0	134.0	160.0	134.0	160.0	134.0	136.0
120.0	134.0	160.0	134.0	160.0	134.0	160.0	134.0	148.0	134.0	134.0

Height (in)	Panel width (in)									
	24.0		30.0		36.0		42.0		48.0	
	Pos	Neg	Pos	Neg	Pos	Neg	Pos	Neg	Pos	Neg
36.0	120.0	160.0	120.0	160.0	120.0	160.0	120.0	160.0	120.0	160.0
42.0	120.0	160.0	120.0	160.0	120.0	160.0	120.0	160.0	120.0	160.0
48.0	120.0	160.0	120.0	160.0	120.0	160.0	120.0	160.0	120.0	160.0
54.0	120.0	160.0	120.0	160.0	120.0	160.0	120.0	160.0	120.0	160.0
60.0	120.0	160.0	120.0	160.0	120.0	160.0	120.0	160.0	120.0	142.0
66.0	120.0	160.0	120.0	160.0	120.0	160.0	120.0	143.8	120.0	134.0
72.0	120.0	160.0	120.0	160.0	120.0	160.0	120.0	138.1	120.0	128.0
78.0	120.0	160.0	120.0	160.0	120.0	146.4	120.0	133.9	120.0	123.0
84.0	120.0	160.0	120.0	160.0	120.0	146.3	120.0	130.4	119.8	119.0
90.0	120.0	160.0	120.0	160.0	120.0	142.7	120.0	127.6	116.7	116.0
96.0	120.0	160.0	120.0	160.0	120.0	140.5	120.0	125.2	114.1	114.0
102.0	120.0	160.0	120.0	160.0	120.0	136.8	120.0	123.2	111.9	111.0
108.0	120.0	160.0	120.0	160.0	120.0	137.0	120.0	121.4	110.1	110.0
114.0	120.0	160.0	120.0	160.0	120.0	135.5	119.9	119.9	108.4	108.0
120.0	120.0	160.0	120.0	160.0	120.0	134.3	119.8	119.8	107.0	107.0

[illegible]

Height (in)		Panel width (in)															
		24.0		30.0		36.0		42.0		48.0		54.0		60.0			
		Pos	Neg	Pos	Neg	Pos	Neg	Pos	Neg	Pos	Neg	Pos	Neg	Pos	Neg		
36.0		100.0	160.0	100.0	160.0	100.0	160.0	100.0	160.0	100.0	160.0	100.0	160.0	100.0	160.0		
42.0		100.0	160.0	100.0	160.0	100.0	160.0	100.0	160.0	100.0	160.0	100.0	160.0	100.0	160.0		
48.0		100.0	160.0	100.0	160.0	100.0	160.0	100.0	160.0	100.0	160.0	100.0	160.0	100.0	160.0		
54.0		100.0	160.0	100.0	160.0	100.0	160.0	100.0	160.0	100.0	160.0	100.0	160.0	100.0	148.0		
60.0		100.0	160.0	100.0	160.0	100.0	160.0	100.0	160.0	100.0	160.0	100.0	148.6	100.0	147.0		
66.0		100.0	160.0	100.0	160.0	100.0	160.0	100.0	160.0	100.0	144.6	100.0	136.3	100.0	134.0		
72.0		100.0	160.0	100.0	160.0	100.0	160.0	100.0	148.4	100.0	137.9	100.0	130.8	100.0	128.0		
78.0		100.0	160.0	100.0	160.0	100.0	160.0	100.0	143.8	100.0	132.8	100.0	126.0	100.0	119.0		
84.0		100.0	160.0	100.0	160.0	100.0	160.0	100.0	140.1	100.0	126.7	100.0	120.5	100.0	114.0		
90.0		100.0	160.0	100.0	160.0	100.0	160.0	100.0	137.1	100.0	126.4	100.0	116.8	100.0	110.0		
96.0		100.0	160.0	100.0	160.0	100.0	160.0	100.0	134.8	100.0	122.6	100.0	113.7	100.0	107.0		

Height	100.0		100.5		101.0		101.5		102.0		102.5		103.0	
	Feet	Inch	Feet	Inch	Feet	Inch	Feet	Inch	Feet	Inch	Feet	Inch	Feet	Inch
5'0"	150.0	150.0	150.5	150.5	151.0	151.0	151.5	151.5	152.0	152.0	152.5	152.5	153.0	153.0
5'1"	150.5	150.5	151.0	151.0	151.5	151.5	152.0	152.0	152.5	152.5	153.0	153.0	153.5	153.5
5'2"	151.0	151.0	151.5	151.5	152.0	152.0	152.5	152.5	153.0	153.0	153.5	153.5	154.0	154.0
5'3"	151.5	151.5	152.0	152.0	152.5	152.5	153.0	153.0	153.5	153.5	154.0	154.0	154.5	154.5
5'4"	152.0	152.0	152.5	152.5	153.0	153.0	153.5	153.5	154.0	154.0	154.5	154.5	155.0	155.0
5'5"	152.5	152.5	153.0	153.0	153.5	153.5	154.0	154.0	154.5	154.5	155.0	155.0	155.5	155.5
5'6"	153.0	153.0	153.5	153.5	154.0	154.0	154.5	154.5	155.0	155.0	155.5	155.5	156.0	156.0
5'7"	153.5	153.5	154.0	154.0	154.5	154.5	155.0	155.0	155.5	155.5	156.0	156.0	156.5	156.5
5'8"	154.0	154.0	154.5	154.5	155.0	155.0	155.5	155.5	156.0	156.0	156.5	156.5	157.0	157.0
5'9"	154.5	154.5	155.0	155.0	155.5	155.5	156.0	156.0	156.5	156.5	157.0	157.0	157.5	157.5
5'10"	155.0	155.0	155.5	155.5	156.0	156.0	156.5	156.5	157.0	157.0	157.5	157.5	158.0	158.0
5'11"	155.5	155.5	156.0	156.0	156.5	156.5	157.0	157.0	157.5	157.5	158.0	158.0	158.5	158.5
6'0"	156.0	156.0	156.5	156.5	157.0	157.0	157.5	157.5	158.0	158.0	158.5	158.5	159.0	159.0

Height (in)	Panel width (in)															
	24.0		30.0		36.0		42.0		48.0		54.0		60.0			
	Pos	Neg	Pos	Neg	Pos	Neg	Pos	Neg	Pos	Neg	Pos	Neg	Pos	Neg		
36.0	100.0	150.0	100.0	150.0	100.0	150.0	100.0	150.0	100.0	150.0	100.0	150.0	100.0	150.0		
42.0	100.0	150.0	100.0	150.0	100.0	150.0	100.0	150.0	100.0	150.0	100.0	150.0	100.0	150.0		
48.0	100.0	150.0	100.0	150.0	100.0	150.0	100.0	150.0	100.0	150.0	100.0	150.0	100.0	150.0		
54.0	100.0	150.0	100.0	150.0	100.0	150.0	100.0	150.0	100.0	150.0	100.0	150.0	100.0	148.0		
60.0	100.0	150.0	100.0	150.0	100.0	150.0	100.0	150.0	100.0	150.0	100.0	148.8	100.0	147.0		
66.0	100.0	150.0	100.0	150.0	100.0	150.0	100.0	150.0	100.0	144.8	100.0	136.3	100.0	134.0		
72.0	100.0	150.0	100.0	150.0	100.0	150.0	100.0	148.4	100.0	137.9	100.0	130.8	100.0	128.0		
78.0	100.0	150.0	100.0	150.0	100.0	150.0	100.0	143.8	100.0	132.8	100.0	126.0	100.0	119.0		
84.0	100.0	150.0	100.0	150.0	100.0	150.0	100.0	140.1	100.0	128.7	100.0	120.5	100.0	114.0		
90.0	100.0	150.0	100.0	150.0	100.0	150.0	100.0	137.1	100.0	126.4	100.0	116.8	100.0	110.0		
96.0	100.0	150.0	100.0	150.0	100.0	150.0	100.0	134.8	100.0	122.8	100.0	113.7	100.0	107.0		

PRODUCT RENEWED
as complying with the Florida
Building Code
Acceptance No. 11-0223-15
Expiration Date JUNE 22, 2016
By Mamuel Pesa
Miami Code Product Control

PRODUCT REVISED
 as complying with the Florida
 Building Code
 Assignment No. 08-1010.12
 Expiration Date 06/22/2011
 by [Signature]
 Miami Dade Product Control
 Division

LUIS R. LOMAS P.E.

Wm. L. Davis
4/8/09

FLORIDA REGISTRATION
NO. 62514

WinDoor

INCORPORATED

7500 AMSTERDAM DRIVE
ORLANDO, FL 32832


Phone: 407.481.8400
Fax: 407.481.0505 www.windowinc.com

Dwg Title:


SERIES 1000 FIXED WINDOW SMALL MISSILE
DESIGN PRESSURE CHARTS

SIZE	Drn By:	DWG NO.	REV
B	JVS	WIND0075	B

SCALE N.T.S.	DATE: 10/28/05	SHEET 2 OF 8
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SERIES 1000 FIXED WINDOW SMALL MISSILE
ANCHOR ELEVATION

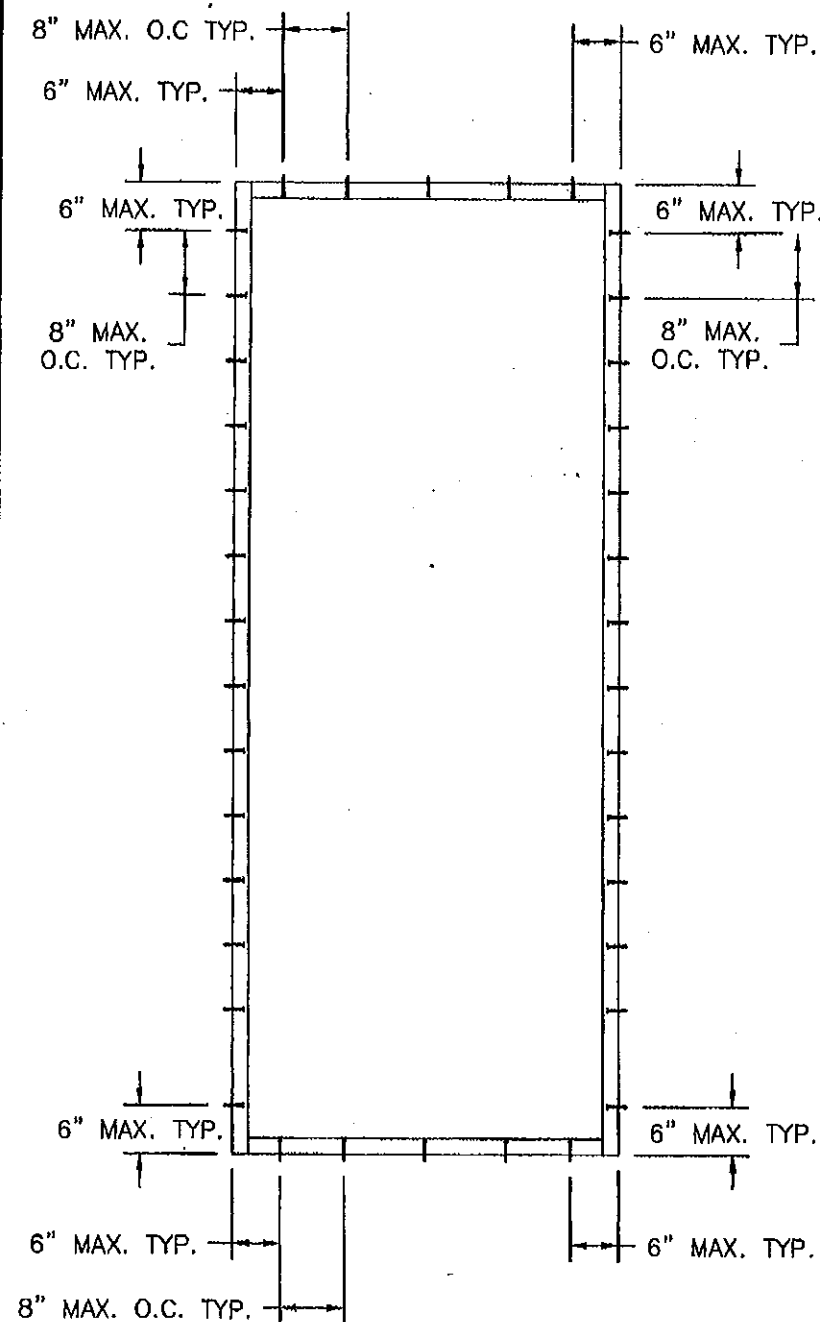

SERIES 1000 FIXED WINDOW SMALL MISSILE
ANCHOR ELEVATION

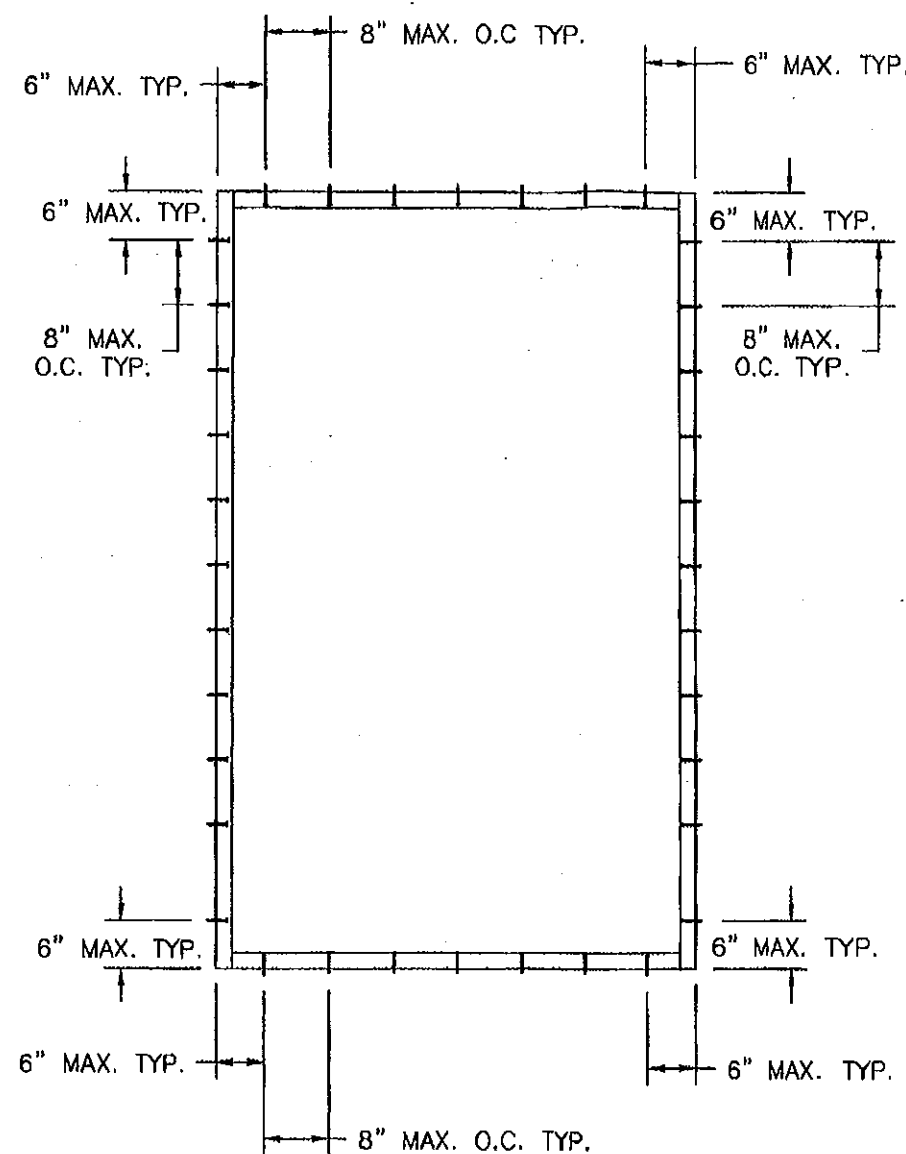INSTALLATION NOTES:

- 1) SHIM AS REQUIRED AT EACH SET OF INSTALLATION ANCHORS USING LOAD BEARING SHIMS, FROM FRONT EDGE TO BACK EDGE TO FULLY SUPPORT FRAME. MAXIMUM ALLOWABLE SHIM STACK TO BE 1/4". USE SHIMS WHERE A SPACE GREATER THAN 1/16" IS PRESENT.
- 2) USE BACKER ROD AND SEALANT BETWEEN SHIM LOCATIONS.
- 3) ONE (1) ANCHOR IS REQUIRED AT EACH ANCHOR LOCATION SHOWN.
- 4) ALL WINDOWS SMALLER THAN SHOWN WILL HAVE ANCHORS LOCATED 6" MAXIMUM FROM CORNERS EACH WAY AND 8" ON CENTER MAXIMUM ON ALL SIDES.
- 5) USE 1/4" DIAMETER ELCO CRETE-FLEX SS4 TYPE MASONRY SCREW ANCHORS OF SUFFICIENT LENGTH TO ACHIEVE 1 1/4" MINIMUM EMBEDMENT, WITH A 1 3/4" MINIMUM EDGE DISTANCE INTO CONCRETE OR MASONRY SUBSTRATE WHERE ONE BY NON-STRUCTURAL WOOD BACKING IS EMPLOYED.
- 6) USE #14 CUT THREAD WOOD SCREWS OF SUFFICIENT LENGTH TO ACHIEVE 1 1/2" MINIMUM EMBEDMENT INTO WOOD FRAMING SUBSTRATE.
- 7) USE #14 CUT THREAD WOOD SCREWS OF SUFFICIENT LENGTH TO ACHIEVE 1 1/2" MINIMUM EMBEDMENT INTO WOOD BACKED STEEL STUD.
- 8) USE #10 X 1 1/4" TEK SCREW IN GLASS STOP 4" FROM CORNERS AND 8" ON CENTER MAXIMUM THEREAFTER.

PRODUCT REVISED
as complying with the Florida
Building Code
Acceptance No 12-0130.27
Expiration Date JUNE 22, 2016

By *Manuel Perez*
Miami Dade Product Control

PRODUCT RENEWED
as complying with the Florida
Building Code
Acceptance No 11-0223.15
Expiration Date JUNE 22, 2016

By *Manuel Perez*
Miami Dade Product Control

PRODUCT REVISED
as complying with the Florida
Building Code
Acceptance No 08-1010.17
Expiration Date 06/22/2011

By *Manuel Perez*
Miami Dade Product Control

LUIS R. LOMAS P.E.

L. Lomas
4/8/09

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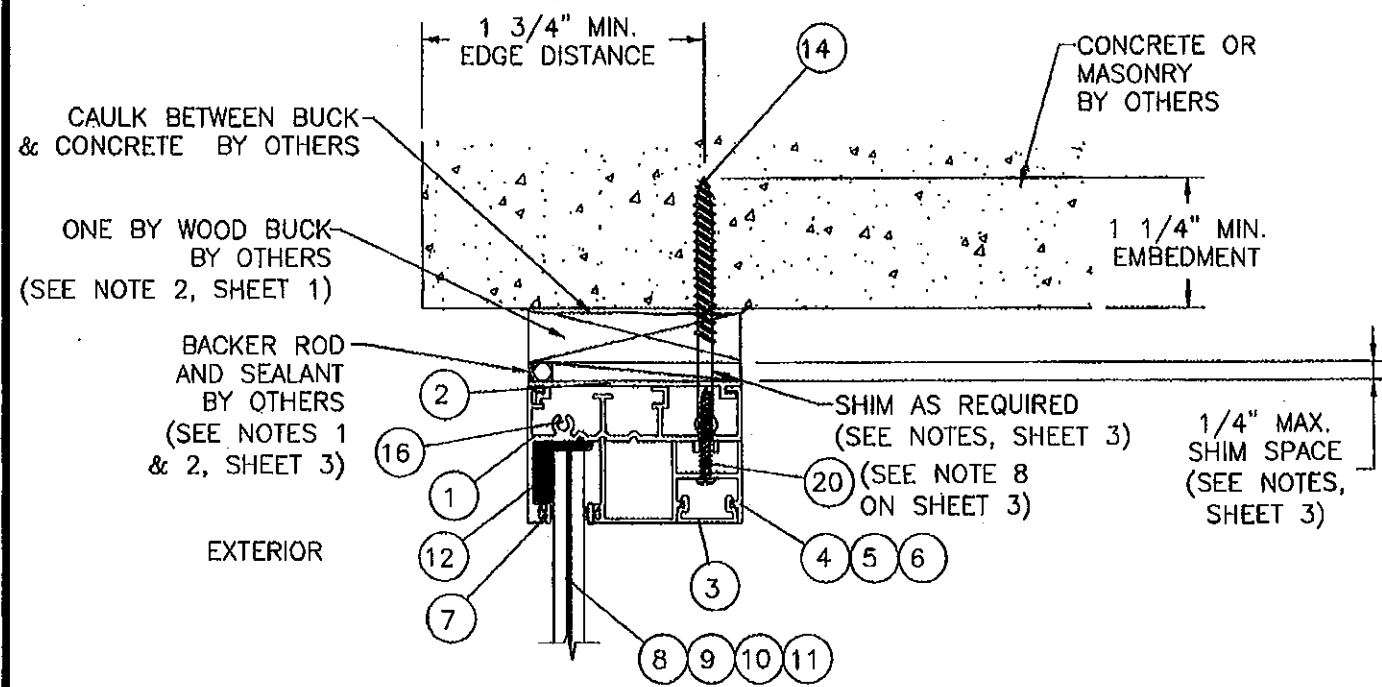
Dwg Title:

SERIES 1000 FIXED WINDOW SMALL MISSILE
ANCHORING ELEVATIONS AND INSTALLATION NOTES


SIZE	Drn By:	DWG NO.	REV
B	JVS	WIND0075	B

SCALE	N.T.S.	DATE:	10/26/05	SHEET	3 OF 8
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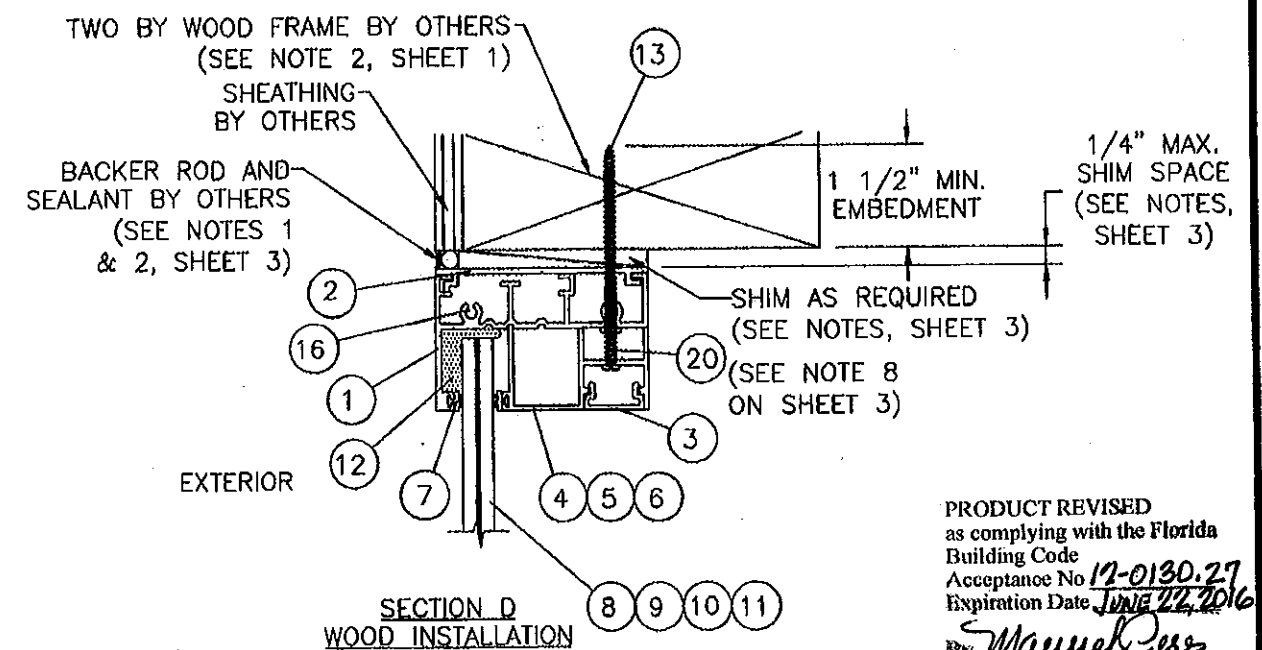
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1	A	General revision and update to current building code	07/31/08	DRL
SHEET	REV	DESCRIPTION	DATE	BY
REVISIONS				




SECTION B
MASONRY INSTALLATION

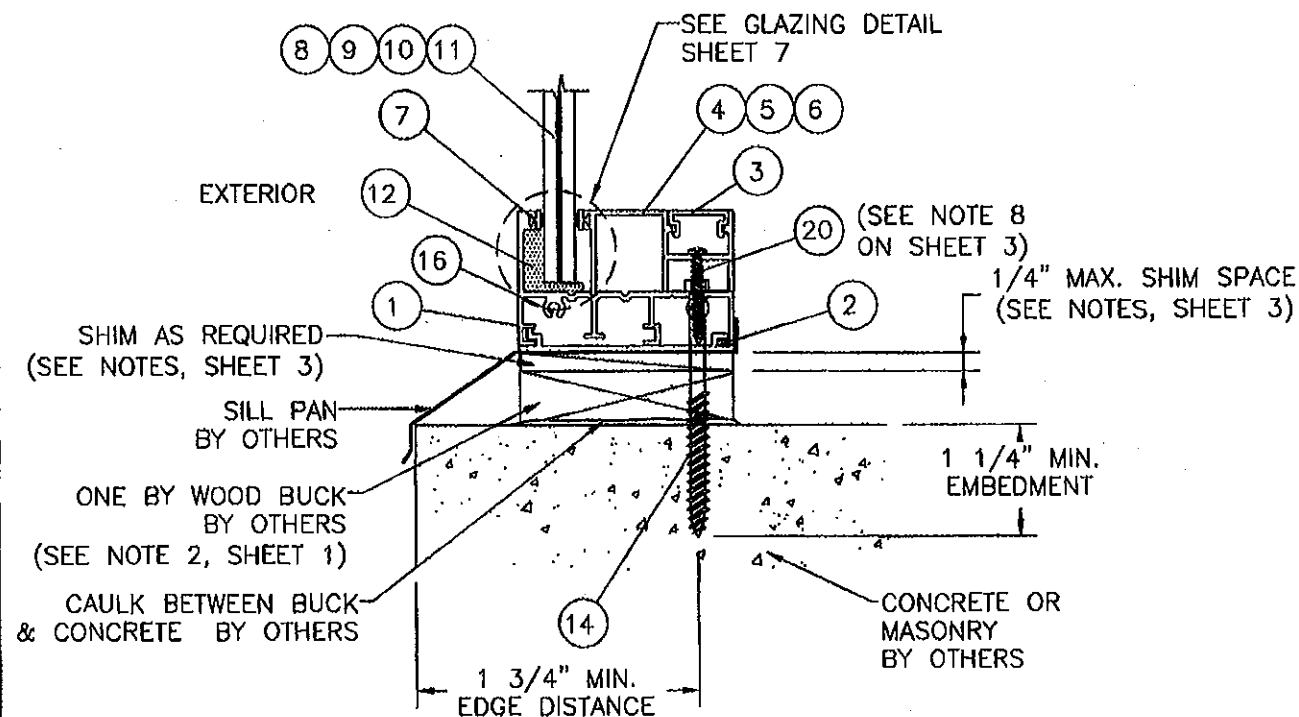

SECTION A
MASONRY INSTALLATION



SECTION D
WOOD INSTALLATION

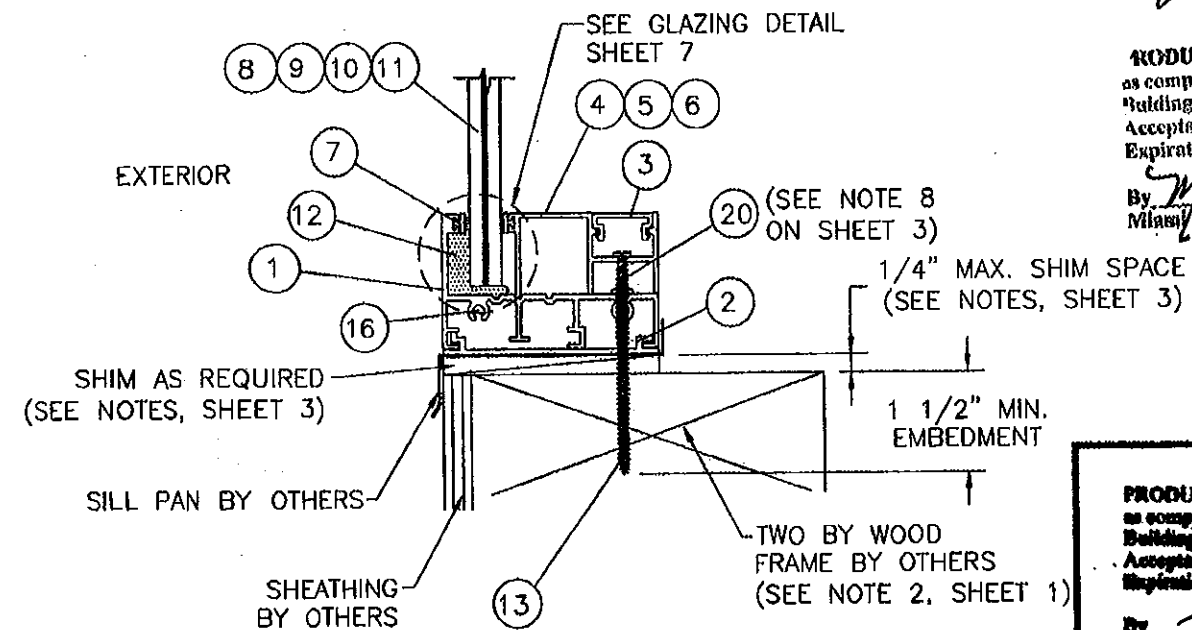

SECTION C
WOOD INSTALLATION

PRODUCT REVISED
as complying with the Florida
Building Code
Acceptance No. 17-0130.27
Expiration Date JUNE 22, 2016
By *Manuel Perez*
Miami/Dade Product Control

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Building Code
Acceptance No. 11-0223.15
Expiration Date JUNE 22, 2016
By *Manuel Perez*
Miami/Dade Product Control

PRODUCT REVISED
as complying with the Florida
Building Code
Acceptance No. 08-1010.12
Expiration Date 06/22/2011
By *[Signature]*
Miami/Dade Product Control
Division

1-8	B	REVISED PER DADE LETTER DATED NOV. 10, 2008	11/26/08	TJH
1-8	A	General revision update to current building code	07/31/08	ORL
SHEET	REV	DESCRIPTION	DATE	BY
REVISIONS				

LUIS R. LOMAS P.E.
[Signature]
2/8/09
FLORIDA REGISTRATION
NO. 62514


WinDoor
INCORPORATED

7500 AMSTERDAM DRIVE
ORLANDO, FL 32832
Phone: 407.481.8400
Fax: 407.481.0505
www.windoorinc.com


Dwg Title: SERIES 1000 FIXED WINDOW SMALL MISSILE VERTICAL CROSS SECTIONS

SIZE	Drn By:	DWG NO.	REV
B	JVS	WIND0075	B

SCALE N.T.S. DATE: 10/28/05 SHEET 4 OF 8

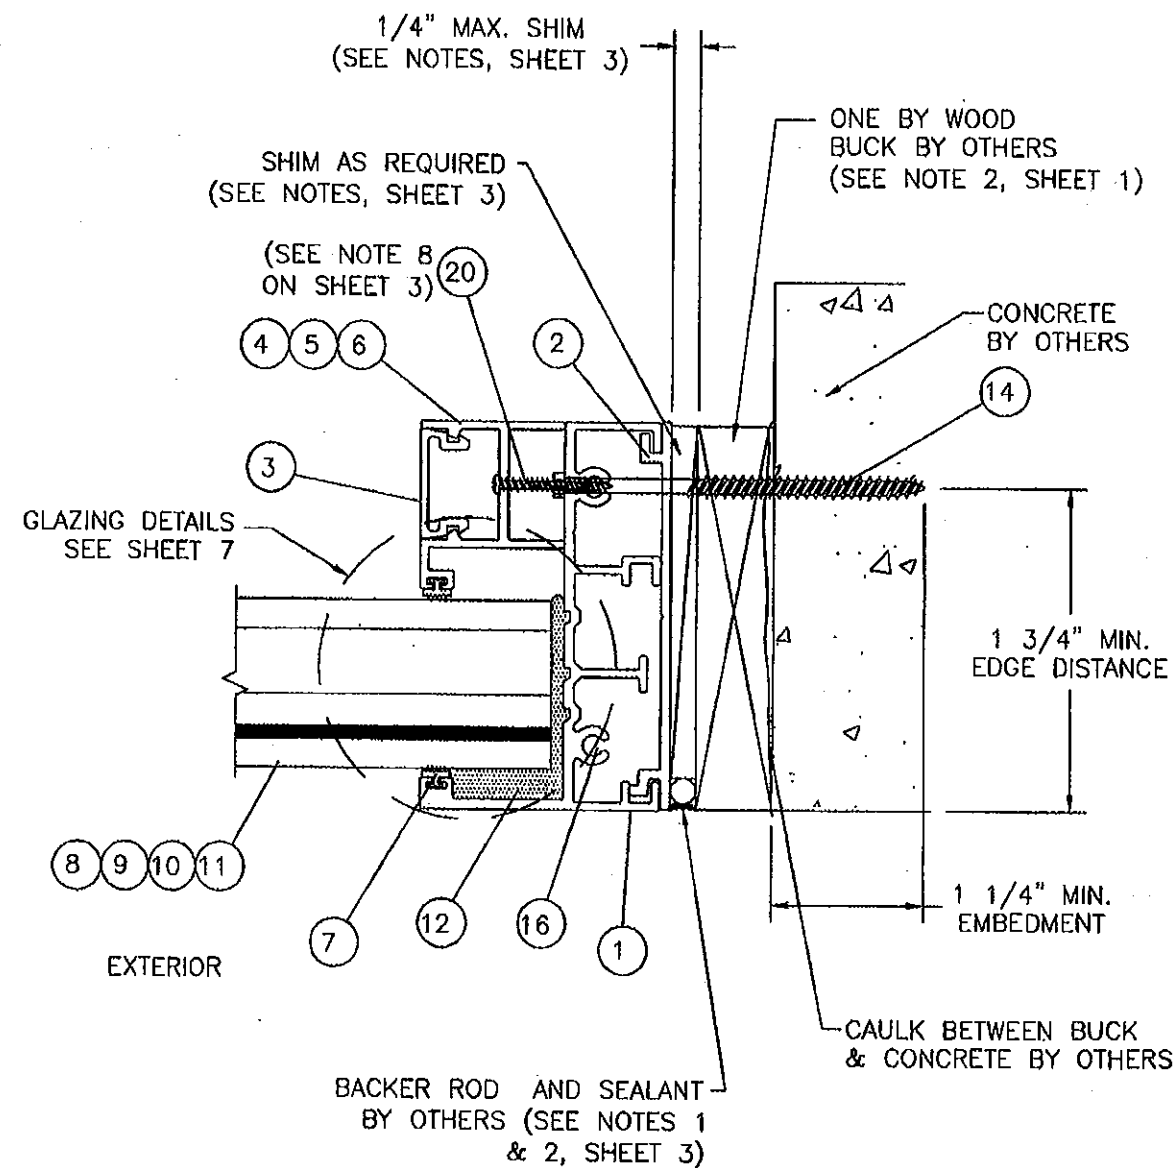

SECTION E
MASONRY INSTALLATION

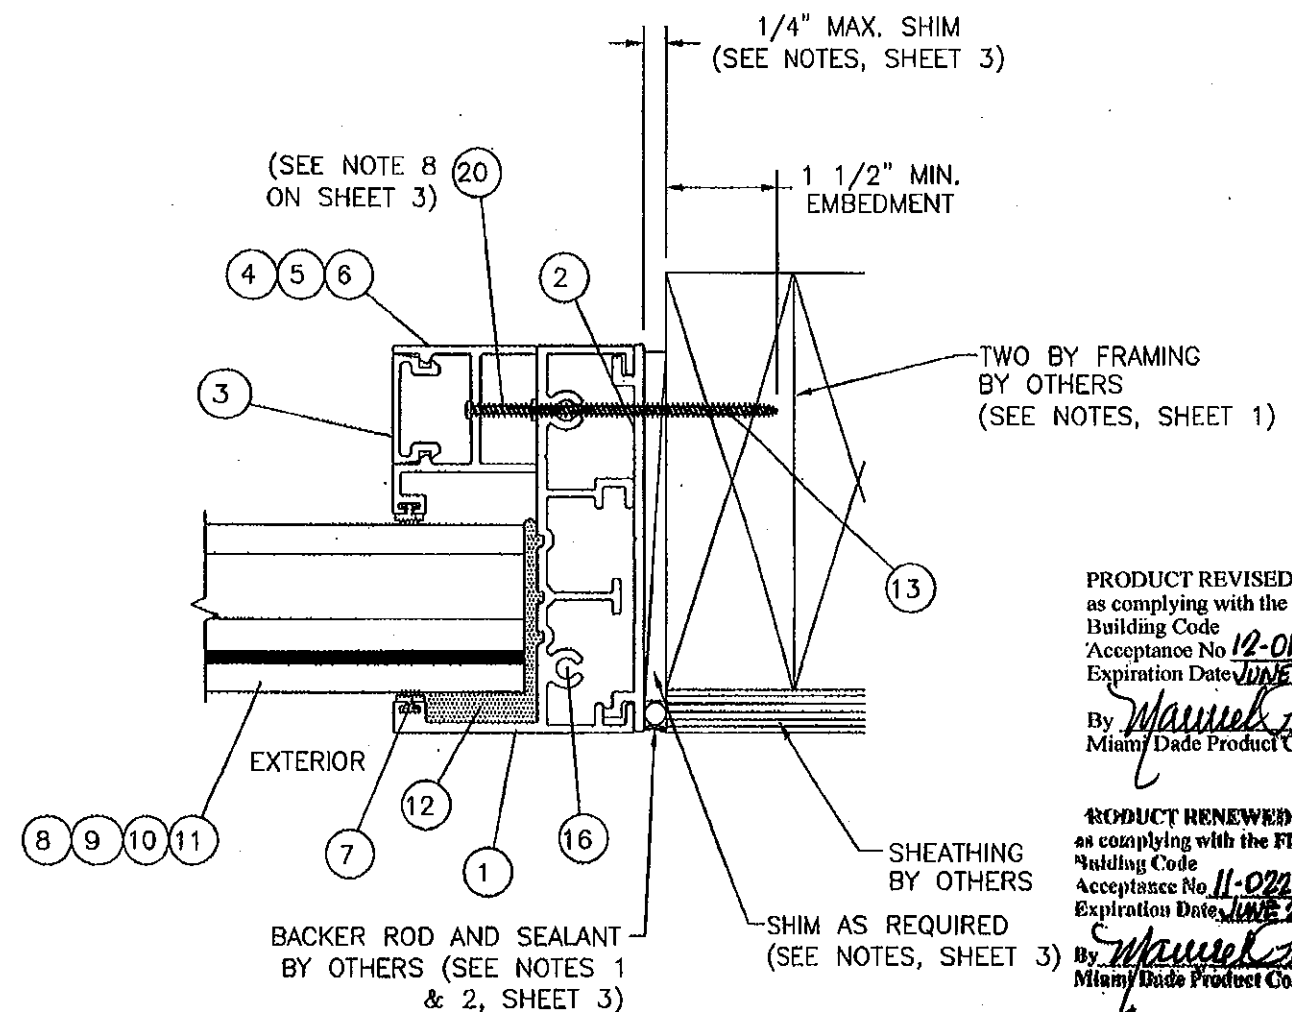

SECTION F
WOOD INSTALLATION

PRODUCT REVISED
as complying with the Florida
Building Code
Acceptance No. 12-0130.27
Expiration Date JUNE 22, 2016

By *Manuel Perez*
Miami Dade Product Control

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Miami Dade Product Control

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Building Code
Acceptance No. 08-1010.12
Expiration Date 06/22/2011

By *Manuel Perez*
Miami Dade Product Control
Division

1-8	B	REVISED PER DADE LETTER DATED NOV. 10, 2008	11/26/08	TJH
1-8	A	General revision update to current building code	07/31/08	DRL
SHEET	REV	DESCRIPTION	DATE	BY
REVISIONS				

LUIS R. LOMAS, P.E.

Luis R. Lomas
2/8/09




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NO. 62514

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ORLANDO, FL 32832
Phone: 407.481.8400
Fax: 407.481.0503
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Dwg Title: SERIES 1000 FIXED WINDOW SMALL MISSILE
HORIZONTAL CROSS SECTIONS

SIZE B	Drn By: JVS	DWG NO. WIND0075	REV B
SCALE N.T.S.	DATE: 10/28/05	SHEET 5 OF 8	



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Building Code
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By: *Mamuel Perez*
Miami Dade Product Control
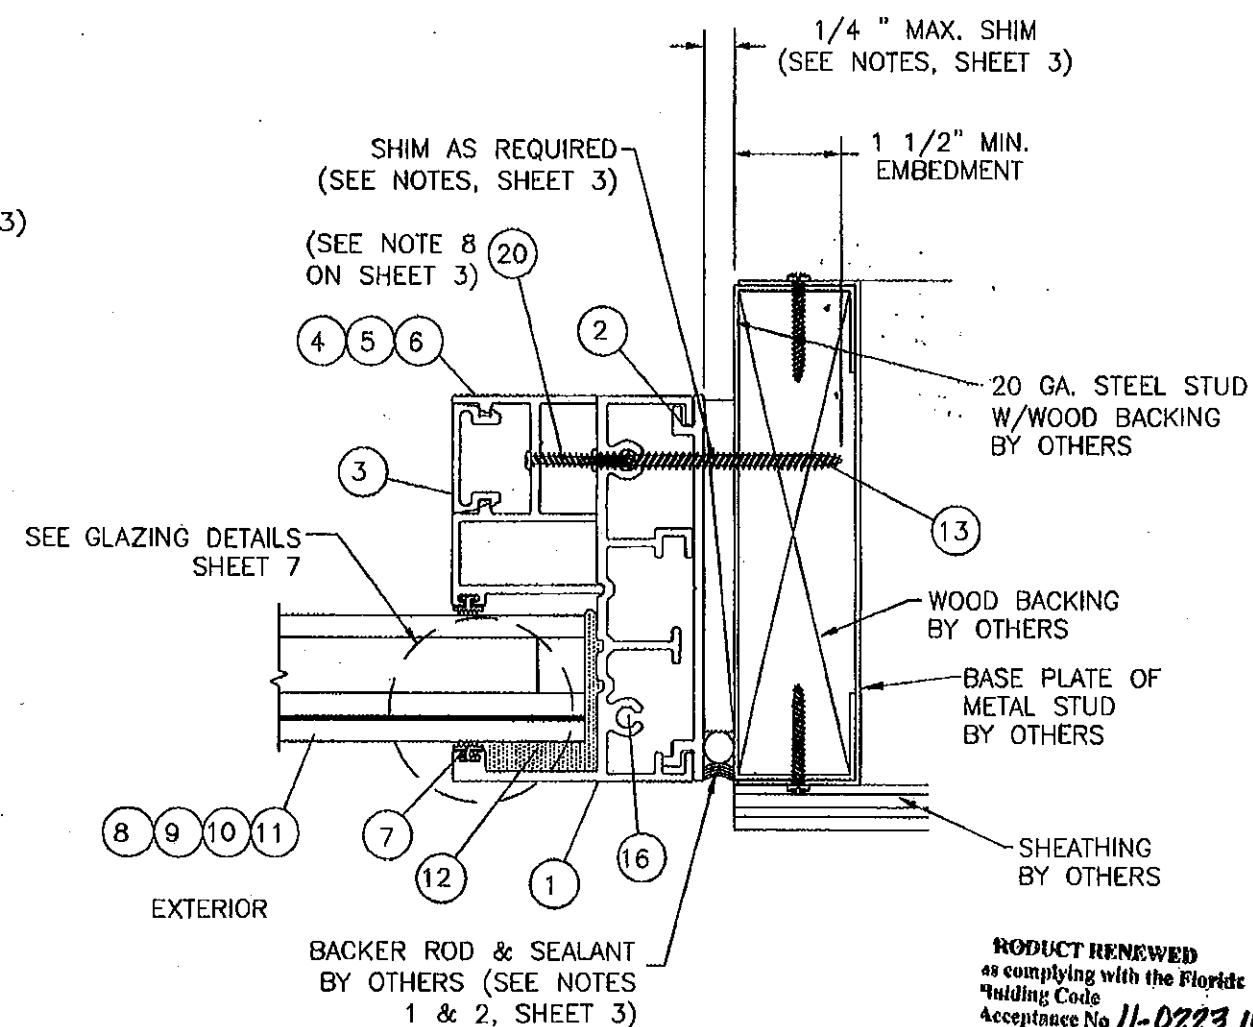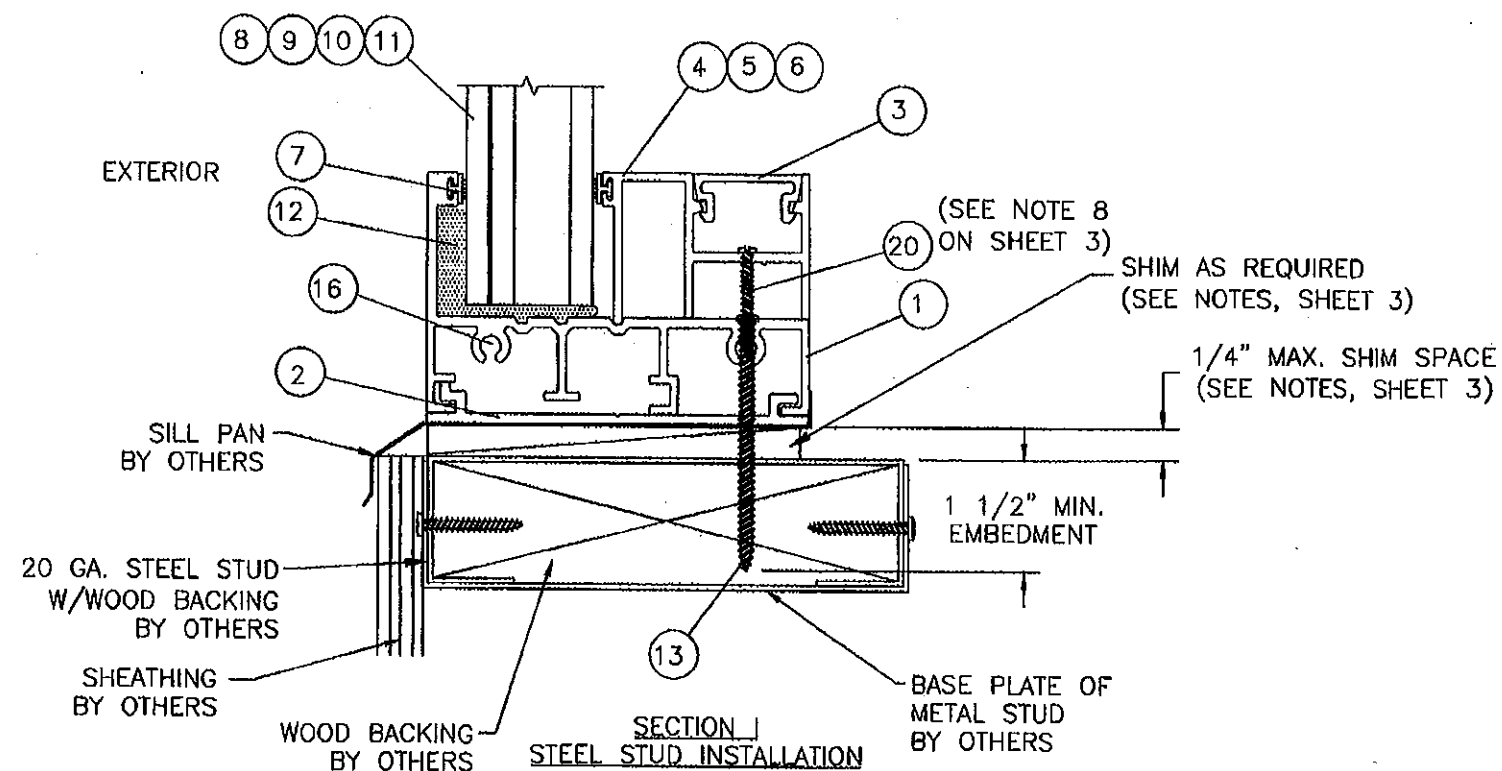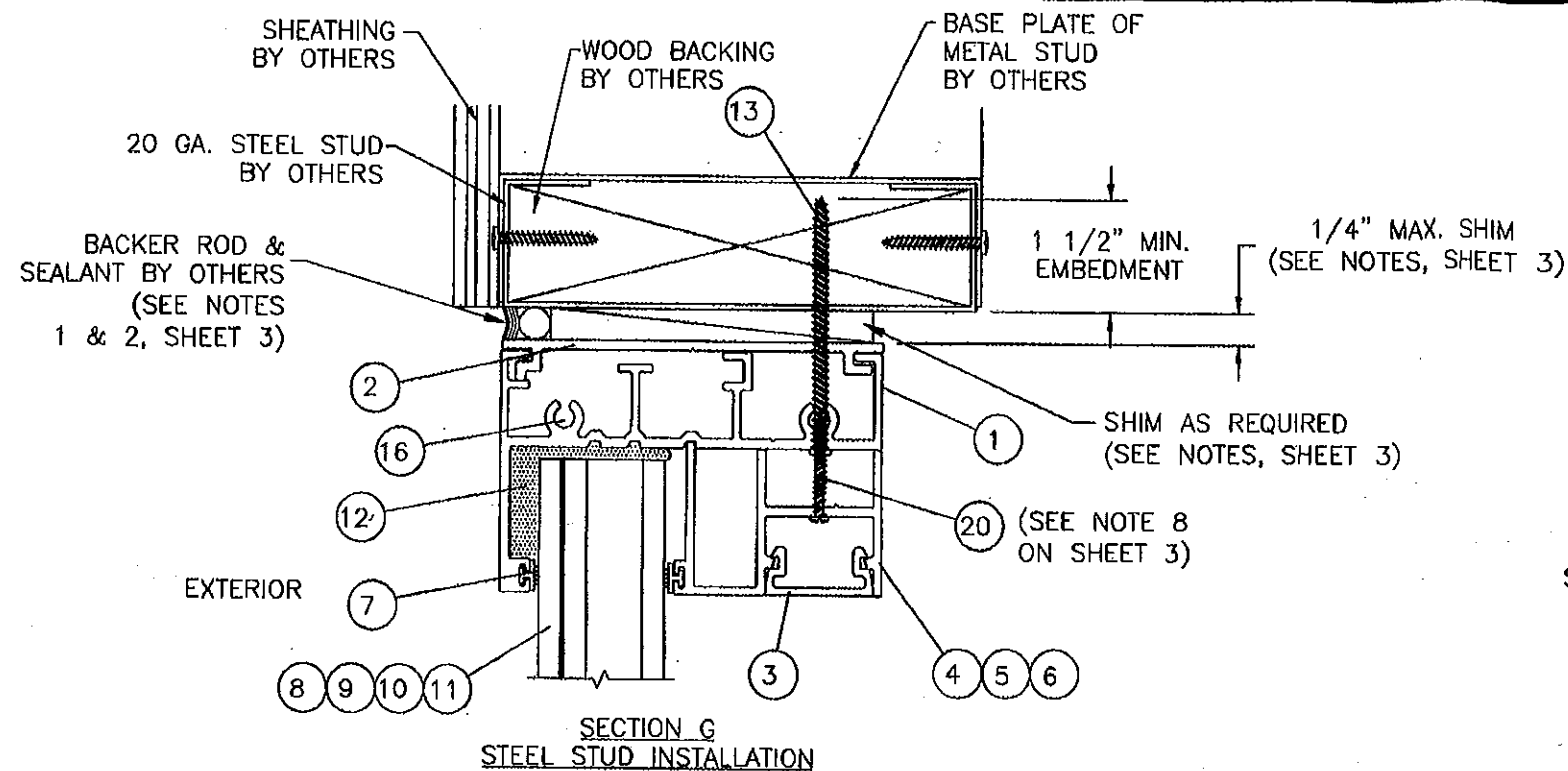
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By: *Mamuel Perez*
Miami Dade Product Control

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Expiration Date: 08/22/2011
By: *[Signature]*
Miami Dade Product Control
Division

1-8	B	REVISED PER DADE LETTER DATED NOV. 10, 2008	11/26/08	TJH
1-8	A	General revision update to current building code	07/31/08	DRL
SHEET	REV	DESCRIPTION	DATE	BY
REVISIONS				

LUIS R. LOMAS P.E.

[Signature]
2/8/09


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NO. 62514

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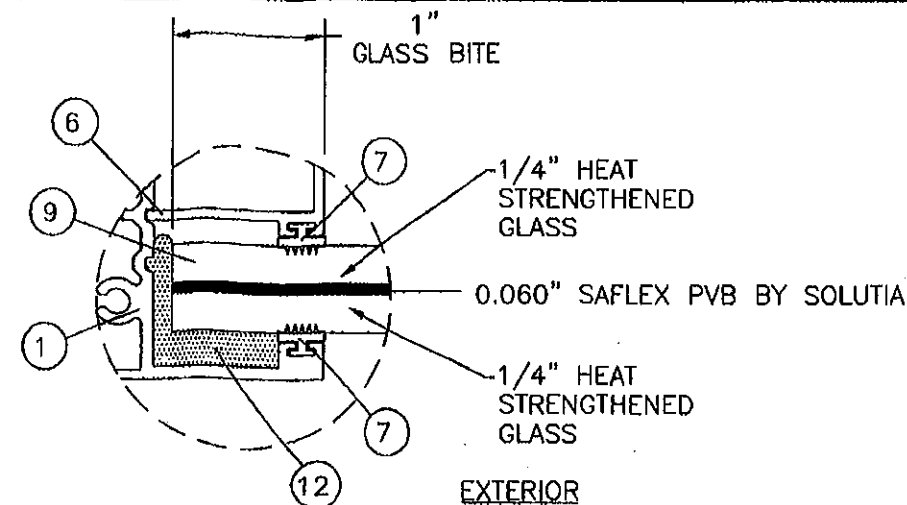
7500 AMSTERDAM DRIVE
ORLANDO, FL 32832
Phone: 407.481.8400
Fax: 407.481.0505
www.windoorinc.com

Dwg Title:
SERIES 1000 FIXED WINDOW SMALL MISSILE
STEEL STUD CROSS SECTIONS


SIZE B	Drn By: JVS	DWG NO. WIND0075	REV B
SCALE N.T.S.	DATE: 10/28/05	SHEET 6 OF 8	

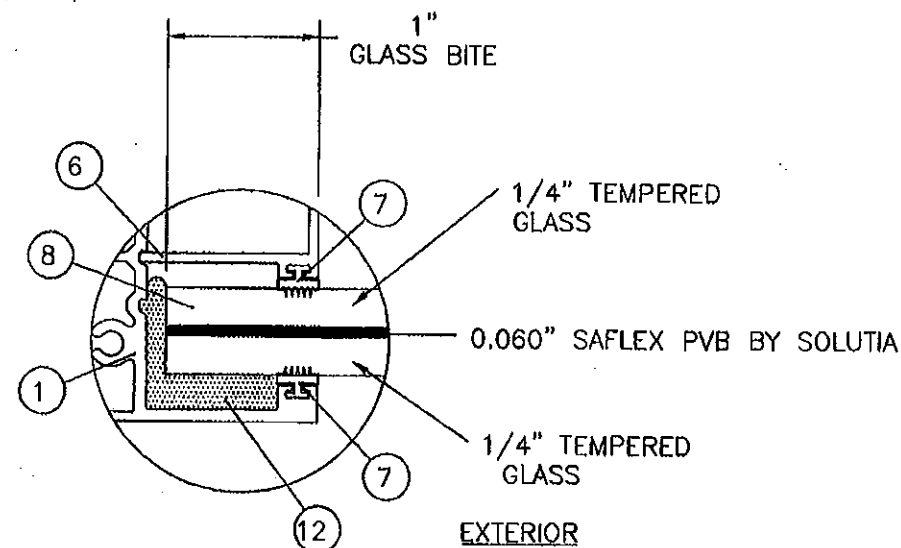


GLAZING DETAIL A
9/16" NOMINAL O.A.
LAMINATED TEMPERED
SMALL MISSILE IMPACT GLASS



GLAZING DETAIL B
9/16" NOMINAL O.A.
LAMINATED HEAT STRENGTHENED
SMALL MISSILE IMPACT GLASS

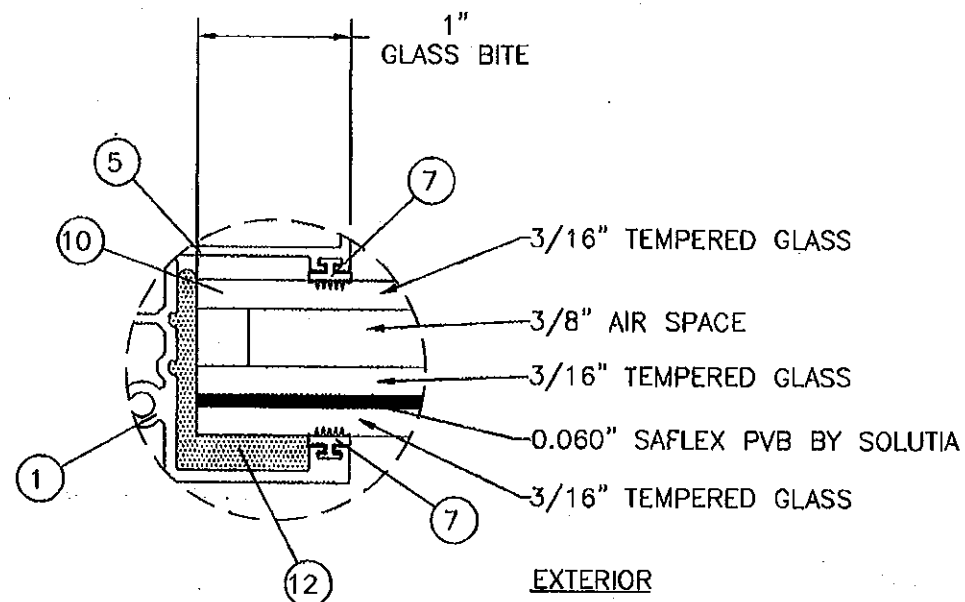

GLAZING DETAIL C
1" NOMINAL O.A.
INSULATED TEMPERED
SMALL MISSILE IMPACT GLASS

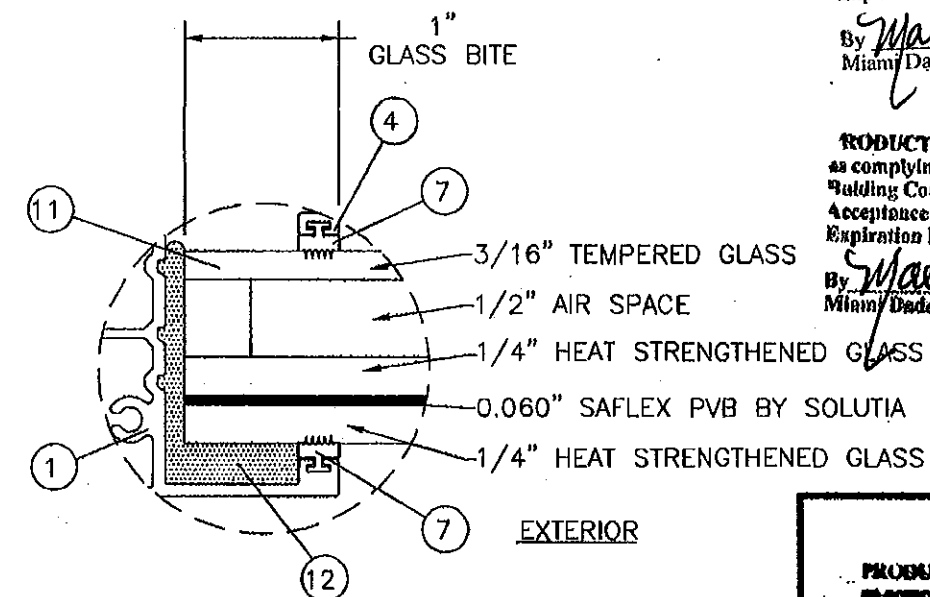

GLAZING DETAIL D
1 1/4" NOMINAL O.A.
INSULATED HEAT STRENGTHENED/TEMPERED
SMALL MISSILE IMPACT GLASS

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Expiration Date 06/22/2011
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SHEET	REV	DESCRIPTION	DATE	BY
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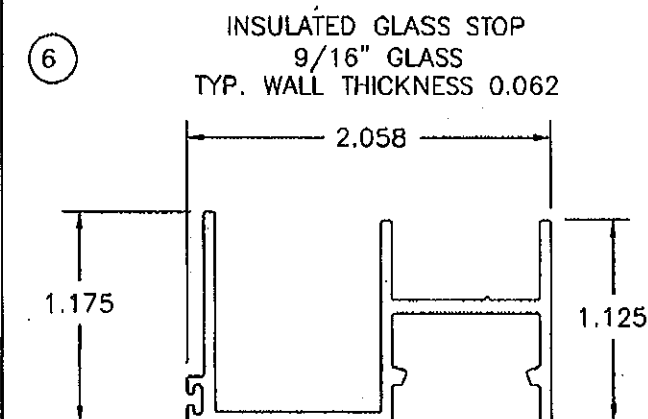
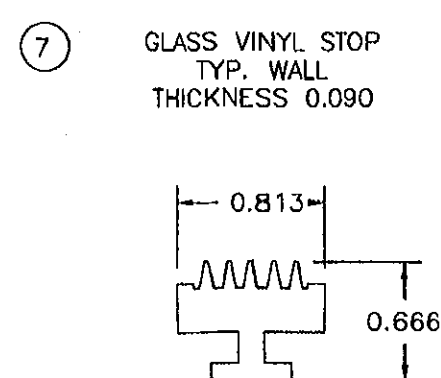
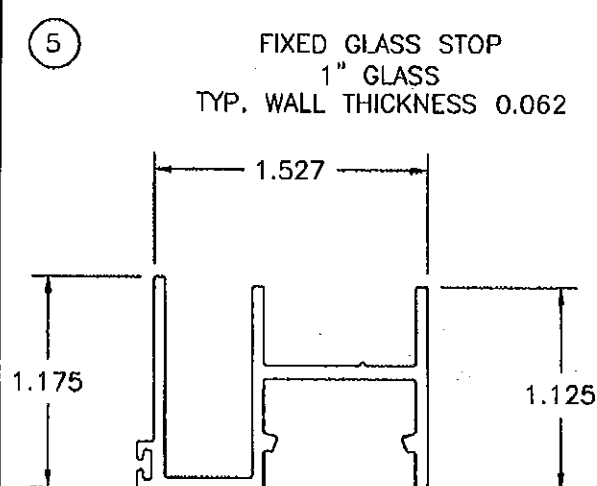
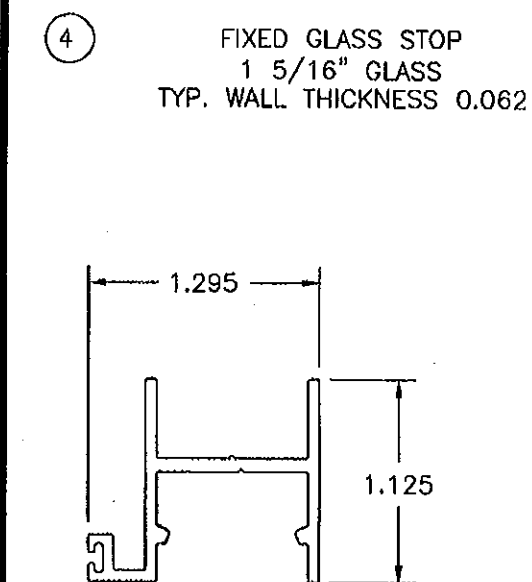
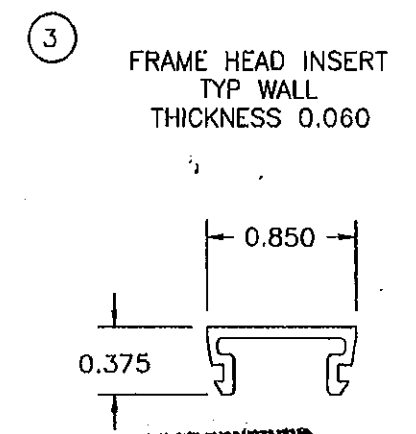
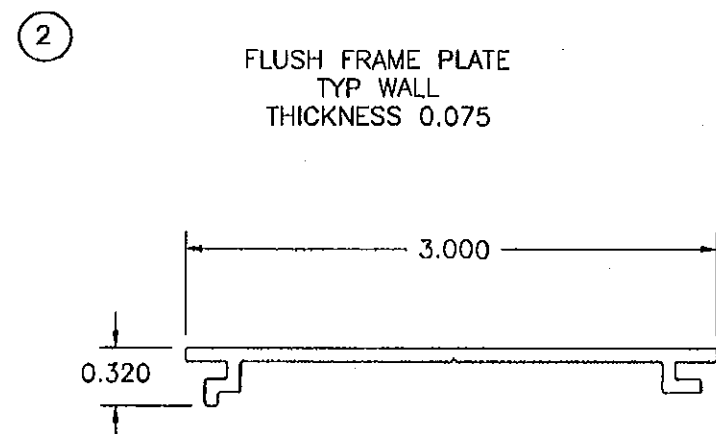
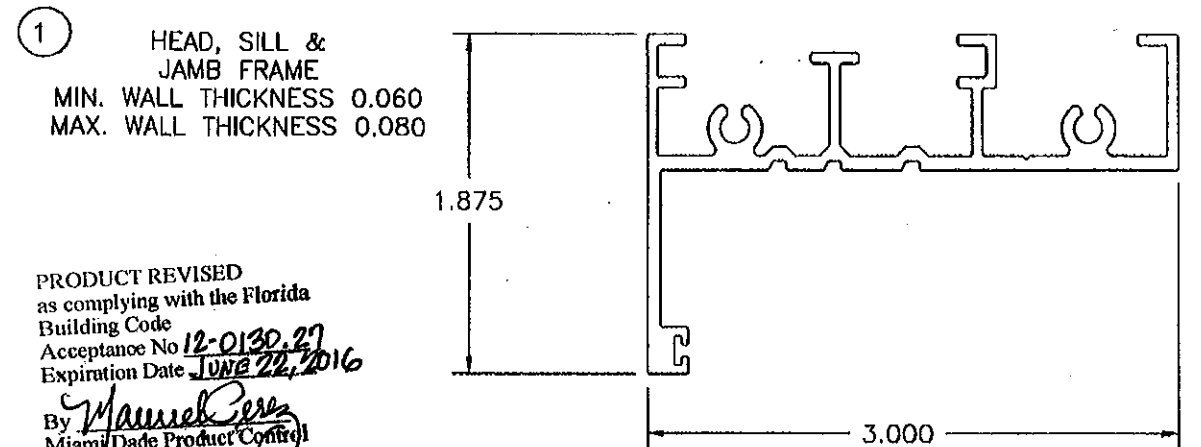
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Dwg Title:
SERIES 1000 FIXED WINDOW SMALL MISSILE
GLAZING DETAILS

SIZE B	Drn By: JVS	DWG NO. WIND0075	REV B
SCALE N.T.S.	DATE: 10/28/05	SHEET 7 OF 8	

BILL OF MATERIAL

NO.	PART NO.	DESCRIPTION
1	FS-02485	HEAD, SILL & JAMB FRAME EXTRUDED ALUM. BY KEYMARK
2	FS-02862	FLUSH FRAME PLATE EXTRUDED ALUM. BY KEYMARK
3	FS-01882	INSERT EXTRUDED ALUM. BY KEYMARK
4	FS-02861	INSULATED GLASS STOP 1 5/16" GLASS EXTRUDED ALUM. BY KEYMARK
5	FS-02478	INSULATED GLASS STOP 1" GLASS EXTRUDED ALUM. BY KEYMARK
6	FS-02479	LAMINATED GLASS STOP 9/16" GLASS EXTRUDED ALUM. BY KEYMARK
7	GS-VN-07A	GLASS STOP VINYL TEAM PLASTICS INC.
8		9/16" OA SINGLE GLAZE SMALL MISSILE TYPE "A" GLAZING DETAIL A
9		9/16" OA SINGLE GLAZE SMALL MISSILE TYPE "B" GLAZING DETAIL B
10		1" OA INSULATED SMALL MISSILE TYPE "C" GLAZING DETAIL C
11		1 1/4" OA INSULATED SMALL MISSILE TYPE "D" GLAZING DETAIL D
12		SIKA 552 GLAZING COMPOUND
13		#14 CUT THREAD WOOD SCREW W/1 1/2" MINIMUM EMBEDMENT
14		1/4" DIAMETER ELCO CRETE-FLEX SS4 TYPE MASONRY SCREW W/1 1/4" MINIMUM EMBEDMENT WITH 1 3/4" MINIMUM EDGE DISTANCE
15		NOT USED
16		#10 X 1 1/4" TYPE F (ASSEMBLY SCREWS)
17		NOT USED
18		NOT USED
19		NOT USED
20		#10 X 1 1/4" SELF TAPPING TEK SCREW



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Dwg Title:
SERIES 1000 FIXED WINDOW SMALL MISSILE
BOM AND WINDOW COMPONENTS

SIZE B	Drn By: JVS	DWG NO. WIND0075	REV B
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SCALE N.T.S. DATE: 10/28/05 SHEET 8 OF 8